

Addendum

Cornell Business + Technology Park 10 Brown Road Ithaca, New York 14850 Tel. (607) 277-7100 Fax (607) 277-1410

Waverly Central School District Waverly, New York

SED NO. 60-01-01-06-0-001-019

Reconstruction to Elm Street Elementary School Phase 1

Tt Project No. 339070-24002

BID Addendum No. 2 to Drawings and Project Manual

May 16, 2025

To: ALL BIDDERS

This ADDENDUM forms a part of the BIDDING AND CONTRACT DOCUMENTS and modifies the following documents: Original DRAWINGS dated December 13, 2024
PROJECT MANUAL dated December 13, 2024, and BID ADDENDUM NO.1 dated May 13, 2025.

Acknowledge receipt of the ADDENDUM in the space provided on the FORM OF PROPOSAL

This ADDENDUM consists of (4) pages and the following:

ATTACHMENTS

PRE-BID REQUEST FOR INFORMATION QUESTIONS/ANSWERS

NEW DRAWINGS (8-1/2 x 11)

BA01B	Partial First Floor Demolition Plan
BA02B	Partial Second Floor Demolition Plan
BA03B	Partial First Floor Plan
BA04B	Partial Second Floor Plan
BS01B	Typical Deck Infill
BM01B	Partial First Floor Demolition Plan
BM02B	Partial Second Floor Demolition Plan
BM03B	Partial First Floor Plan
BM04B	Partial Second Floor Plan
BE01B	Partial First Floor – Demolition Plan
BE02B	Partial Second Floor – Demolition Plan
BE03B	Partial First Floor – Power & Comm Plan
BE04B	Partial Second Floor - Power & Comm Plan

NEW DRAWINGS (11 x 17)

BM05B Partial Roof Plans BM06B Partial Roof Plan

PROJECT MANUAL MODIFICATIONS - MECHANICAL

ITEM 2-C-1: Refer to SECTION 23 82 00 – TERMINAL HEATING AND COOLING UNITS

- 1. Paragraph 2.2, E, 1, c., AMEND to read as follows:
 - "c. Building Automation System Interface: Wireless web-enabled BACnet capable controller to allow for remote control."

DRAWING MODIFICATIONS - HAZARDOUS MATERIAL

ITEM 2-C-2: Refer to DRAWING BH102

1. Detail 1, <u>ADD</u> (2) instances of keynote B at the southwest portion of the building (corresponding drawing grid locations L2 & L6). Refer to 1/BM133 for approximate size and location of RTH-2 & RTH-3.

DRAWING MODIFICATIONS - ARCHITECTURAL

ITEM 2-C-3: Refer to DRAWING BA101

1. Detail 1, <u>AMEND</u> as shown on Drawing BA01B attached to this addendum.

ITEM 2-C-4: Refer to DRAWING BA102

1. Detail 1, AMEND as shown on Drawing BA02B attached to this addendum.

ITEM 2-C-5: Refer to DRAWING BA130

- 1. Detail 1, <u>AMEND</u> as shown on Drawing BA03B attached to this addendum.
- 2. Detail 1, at new UV louver openings in Rooms 117 and 121, ADD the following note:

"NEW LOUVER OPENING, SIZE TO BE 78 1/8" X 10 3/8" VERIFY FINAL SIZE WITH MECHANICAL CONTRACTOR AFTER SUBMITTALS ARE APPROVED AND FINAL EQUIPMENT SELECTIONS ARE MADE."

ITEM 2-C-6: Refer to DRAWING BA131

- 1. Detail 1, <u>AMEND</u> as shown on Drawing BA04B attached to this addendum.
- 2. Detail 1, at new UV louver opening in Room 205, <u>ADD</u> the following note:

"NEW LOUVER OPENING, SIZE TO BE 78 1/8" X 10 3/8", COORDINATE FINAL SIZE WITH MECHANICAL CONTRACTOR AFTER SUBMITTALS ARE APPROVED AND FINAL EQUIPMENT SELECTIONS ARE MADE."

3. Detail 1, at new PTAC louver openings in Rooms 203A and 203B, ADD the following note:

"NEW LOUVER OPENING, SIZE TO BE 42" X 16 1/16", COORDINATE FINAL SIZE WITH MECHANICAL CONTRACTOR AFTER SUBMITTALS ARE APPROVED AND FINAL EQUIPMENT SELECTIONS ARE MADE."

DRAWING MODIFICATIONS - STRUCTURAL

ITEM 2-C-7: Refer to DRAWING BS130

1. <u>ADD</u> Drawing BS01B attached to this addendum.

DRAWING MODIFICATIONS - MECHANICAL

ITEM 2-C-8: Refer to DRAWING BM101

1. Detail 1, AMEND as shown on Drawing BM01B attached to this addendum.

ITEM 2-C-9: Refer to DRAWING BM102

1. Detail 1, <u>AMEND</u> as shown on Drawing BM02B attached to this addendum.

ITEM 2-C-10: Refer to DRAWING BM131

1. Detail 1, <u>AMEND</u> as shown on Drawing BM03B attached to this addendum.

ITEM 2-C-11: Refer to DRAWING BM132

1. Detail 1, <u>AMEND</u> as shown on Drawing BM04B attached to this addendum.

ITEM 2-C-12: Refer to DRAWING BM600

1. 'Packaged Terminal Air Conditioner (PTAC) Schedule, <u>ADD</u> note 6 to PTAC-203.3, PTAC-203.4 and PTAC-209 to read as follows:

"6. PROVIDE WITH WIRELESS WEB-ENABLED BACNET CAPABLE CONTROLLER"

DRAWING MODIFICATIONS - ELECTRIC

ITEM 2-C-13: Refer to DRAWING BE101

1. Detail 1, <u>AMEND</u> as shown on Drawing BE01B attached to this addendum.

ITEM 2-C-14: Refer to DRAWING BE102

1. Detail 1, <u>AMEND</u> as shown on Drawing BE02B attached to this addendum.

ITEM 2-C-15: Refer to DRAWING BE161

1. Detail 1, <u>AMEND</u> as shown on Drawing BE03B attached to this addendum.

ITEM 2-C-16: Refer to DRAWING BE162

1. Detail 1, <u>AMEND</u> as shown on Drawing BE04B attached to this addendum.

END OF ADDENDUM



INSTRUCTIONS TO BIDDERS ATTACHMENT #1: PRE-BID REQUEST FOR INTERPRETATION FORM

SUBMIT FORM BY EMAIL TO INE.Waverly@tetratech.com

Project No.: 339070-24002	Date: 5/9/25
Project Name: Reconstruction to Elm Street Elen	•
Bidder Contact Person: Steve Maybeck Bidder Company Name: Day Automation Sy Bidder Phone: (585) 202-4247 Bidder Email Address: steve.maybeck@day	
Question Pertains to:	
Drawing Number: Plan Area: Room Number: Drawing Detail Number: Specification Section:	
series with the UV control valve? 2. Drawing BM700 Detail 3 Sequence item 1.b. states that spa space sensors recently installed in this School District have no space temperature sensors? (Temperature setpoint adjustmer 3. Drawing BM700 Detail 3 Sequence of Operation refers to controls work associated with relief air. Which existing relief ve and/or actuators required? 4. Specification 238200 2.2 E. calls for packaged controls for the series of	TUV's. Is a separate control valve required for the radiation, or is it piped in the temperature sensors shall be capable of setpoint adjustment. Other that this capability. Is temperature adjustment capability required at the trace can be done from the DDC system Front End). Introl of relief air and/or exhaust fans. Please clarity the scope of the intilators require new controls (are some gravity reliefs)? Are new dampers are PTAC Units. Control schematic 5/BM700 calls for DDC controls for the especify PTAC Units to have RGYW connections for DDC interface.
Review by Architect/Engineers:	Responded By: P. Moloney Date: 5/15/25
 The FTR shown on drawings BM131 a Provide setpoint adjustment capability Refer to addendum #2. Refer to addendum #2. 	nd BM132 is enclosure only with no element. oer BM700, detail 3.

Tetra Tech INSTRUCTION TO BIDDERS Architects & Engineers Page ITB-9 Project No. 339070-24002

Submit requests not less than 5 working days prior to the specified Bid Opening date and time. In the event that this question requires clarification or modification of the Bidding Documents, such written information can only

be provided by formal Addendum, distributed to all plan holders.



INSTRUCTIONS TO BIDDERS ATTACHMENT #1: PRE-BID REQUEST FOR INTERPRETATION FORM

SUBMIT FORM BY EMAIL TO INE. Waverly@tetratech.com

Project No.: 339070-24002	Date: 5/9/2025
Project Name: Reconstruction to Elm Street Elementary School	· · · · · · · · · · · · · · · · · · ·
Bidder Contact Person: DON ROTTMANN Bidder Company Name: STREETER ASSOCIATES Bidder Phone: 607 - 734 - 4151 Bidder Email Address: STREETER @ STREETER ASSOCIATES	
Question Pertains to:	
Drawing Number: BS130 Peof FRAMING Plan Area: Room Number: Drawing Detail Number: Specification Section:	
Question: (Please be specific) ROOF RAILS" ARE SHOWN For 7 RTU'S. OPENINGS THIZU THE DECK, ON FOR TH	HOTHING IS SHOWN FOR
ACCORDING TO 8/BM 500 THESE RAIL	S SET ON TOP OF THE ROOF DE
AND NOTHING 15 Stown For TH RTH'S.	PLEASE CLAIRIPY THE ACTUAL OP
AND WHERE / HOW THE MAME FIT	5 WITHIN DECK.
Review by Architect/Engineers: Responded	By: Date:
AND HOW ARE THE ABOVE DEX TO	24125 FLASHED IN TO KOOF
Rail Systems are supporting remote condensing units not RTU's sonsociated with the rails. Flashing details are on BM500. There are opening framings per detail on BS130, coordinate with mechanical areas are joists with metal and concrete deck.	re a few small roof hoods which will need roof
areas are joists with metal and concrete deek.	N. Clark 5/14/2025
Submit requests not less than 5 working days prior to the specification or modification of the Biddir be provided by formal Addendum, distributed to all plan holders	g Documents, such written information can only



INSTRUCTIONS TO BIDDERS ATTACHMENT #1: PRE-BID REQUEST FOR INTERPRETATION FORM

SUBMIT FORM BY EMAIL TO INE. Waverly@tetratech.com

Project No.: 339070-24002	Date: 5/15/2025
Project Name: Reconstruction to Elm Street Elementary School	,
Bidder Contact Person: DON ROTTMANN Bidder Company Name: STREETER ASSOCIATES IN Bidder Phone: 607 - 734 - 4151 Bidder Email Address: STREETER ASSOCIATES	
Question Pertains to:	C
Drawing Number: BM 133 + BH 102, BM 103 Plan Area: Room Number:	1 9
Drawing Detail Number:	
Specification Section:	° - 6
Question: (Please be specific) ROOF ABATEMENT DWG IS HISSING ACM RO RTHZ & RTH3.	of cuts @ 1928 Spot ton
Ads Dwgs DO NOT DETAIL DECK INFILL	AS NEBOTO E. MAC B
of two Hood/curss AT N.E. CORNER	of 1938 3105 -
15 CONCRETE NEEDED TO INFILL "1724 DEC	N. Clark Date: 5/15/2025
Roofing penetrations at RTH-2 & RTH-3 will impact ACM roofing a Bid Addendum 2.	and will require abatement. Refer to
Refer to Bid Addendum 2 for BS01B typical deck infill detail.	
Submit requests not less than 5 working days prior to the specified E this question requires clarification or modification of the Bidding Do be provided by formal Addendum, distributed to all plan holders.	

Tetra Tech Architects & Engineers



Project No.: 339070-24002

INSTRUCTIONS TO BIDDERS ATTACHMENT #1: PRE-BID REQUEST FOR INTERPRETATION FORM

SUBMIT FORM BY EMAIL TO INE. Waverly@tetratech.com

1 1 1
DROTTMANN @
BRIOR WAR
EVE THRU WALL

Review by Architect/Engineers:


Refer to Bid Addendum #2.


Submit requests not less than 5 working days prior to the specified Bid Opening date and time. In the event that this question requires clarification or modification of the Bidding Documents, such written information can only be provided by formal Addendum, distributed to all plan holders.


(FOR FIGURING OFENING SIZE AND LINTELS)


Responded By: P. Moloney Date: 5/16/25


Date: 5/15/2025

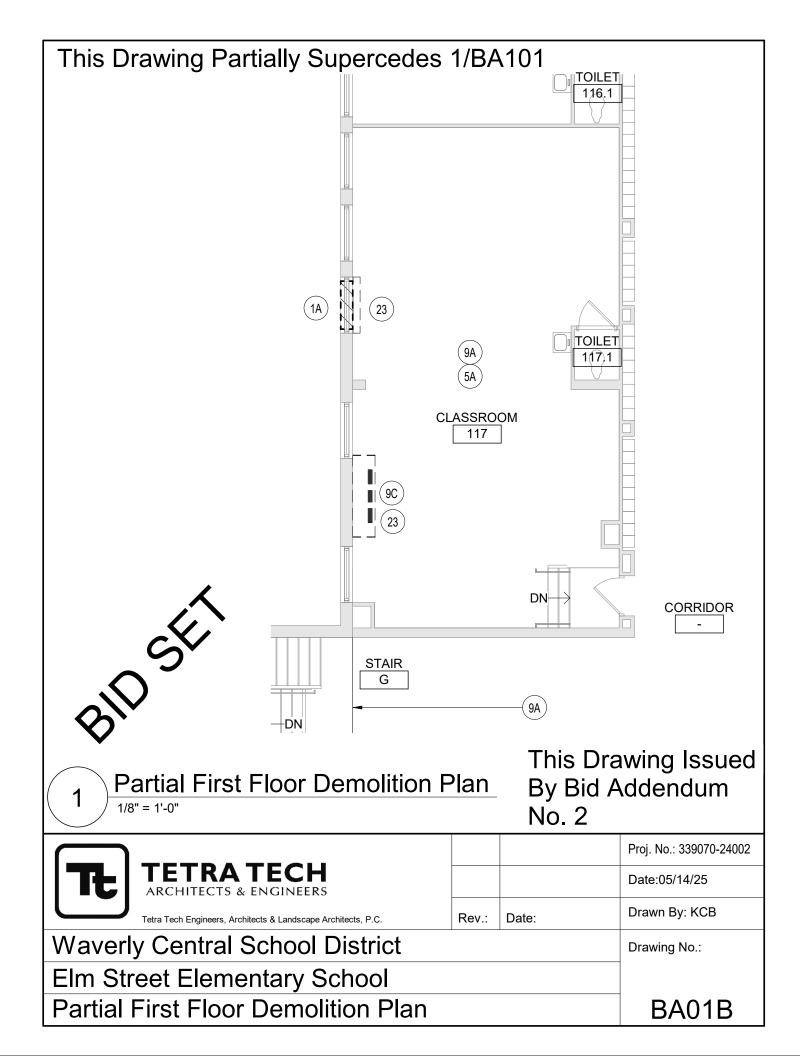

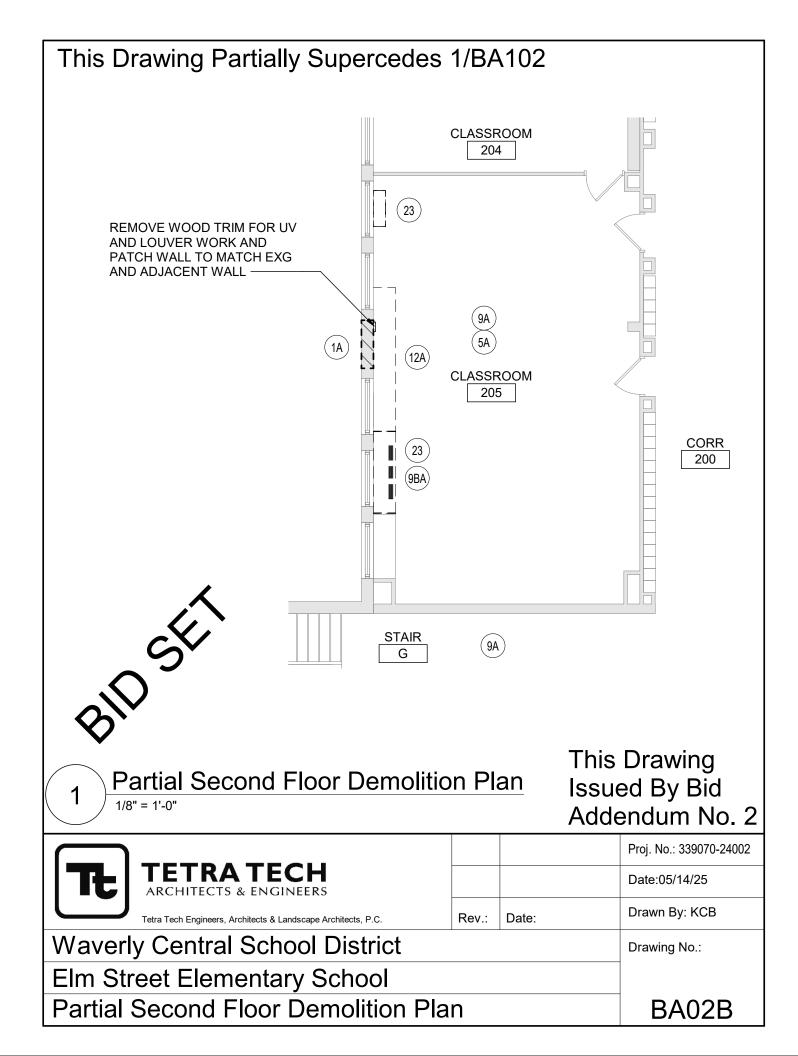

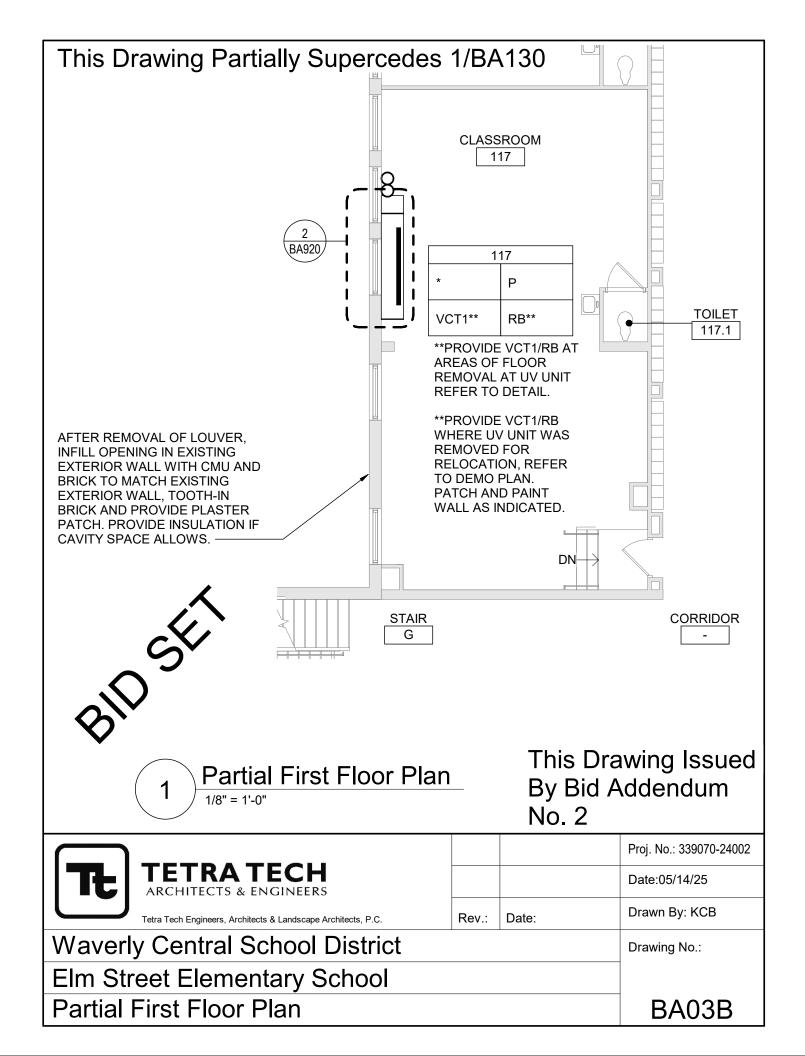


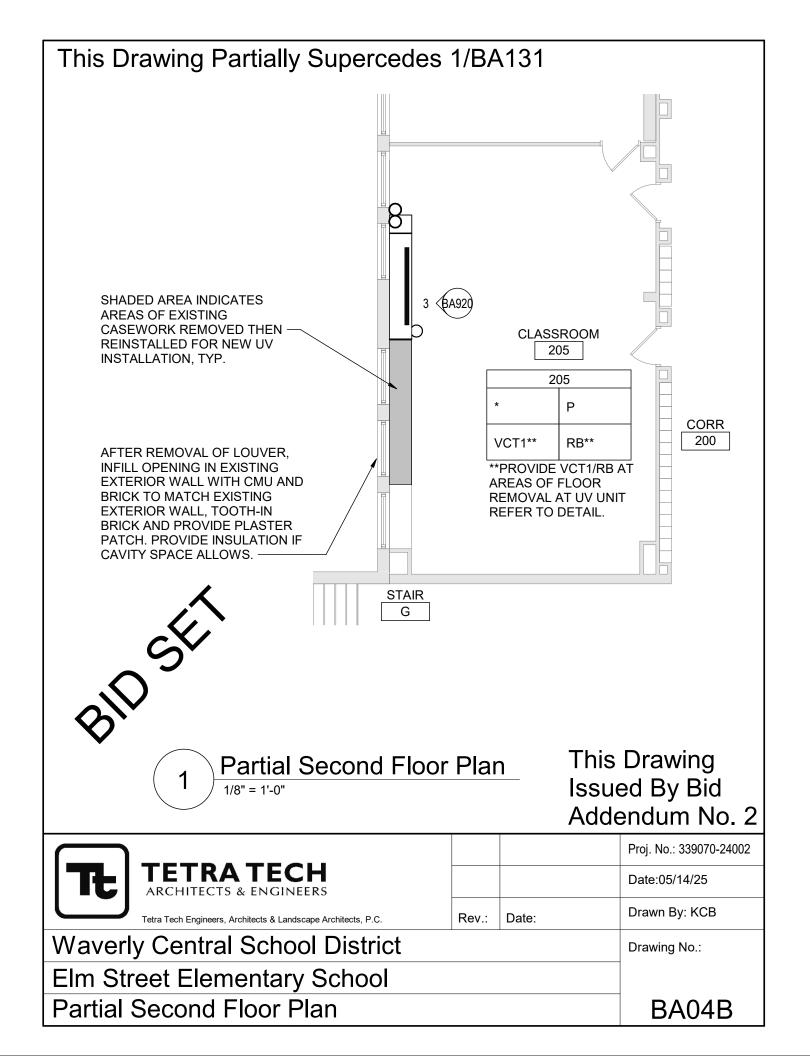

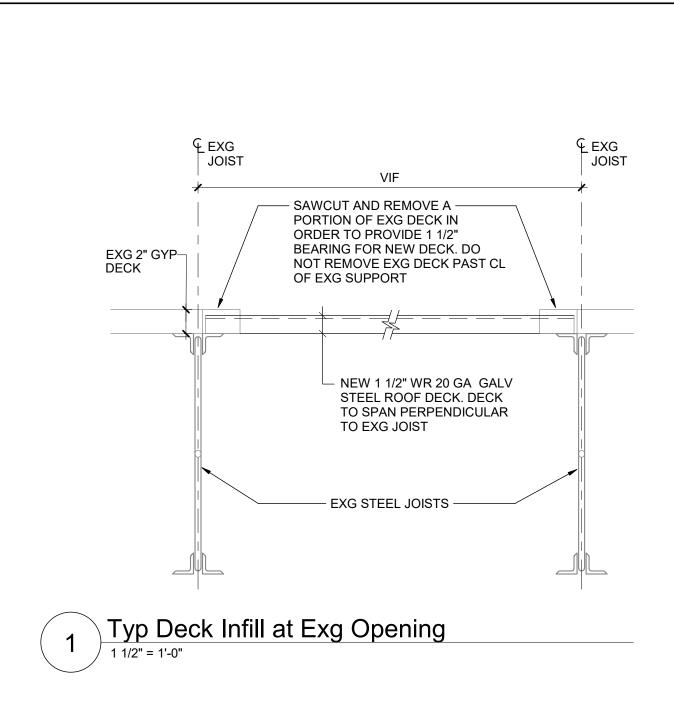


Issued by Bid Addendum No. 2

			Proj. No.: 339070-24002
TETRATECH ARCHITECTS & ENGINEERS			Date:05/15/25
Tetra Tech Engineers, Architects & Landscape Architects, P.C.	Rev.:	Date:	Drawn By: NDC
Waverly Central School District			Drawing No.:
Elm Street Elementary School			
Typ Deck Infill at Exg Opening			BS01B

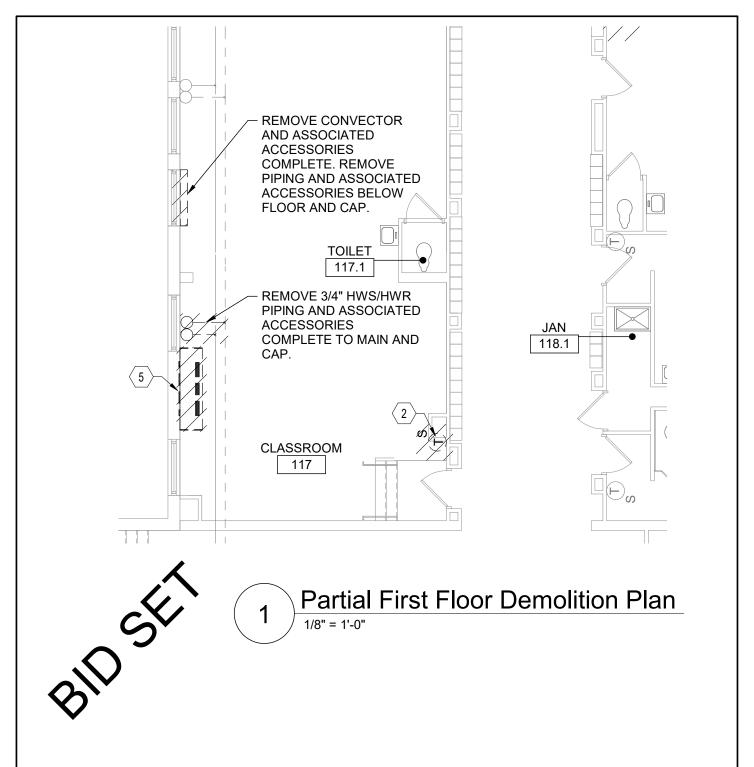


Issued By Bid Addendum #2

				Proj. No.: 339070-24002
T t	TETRA TECH ARCHITECTS & ENGINEERS			Date:05/15/25
	Tetra Tech Engineers, Architects & Landscape Architects, P.C.	Rev.:	Date:	Drawn By: pgm/DPM
Waverly Central School District			Drawing No.:	
Elm Street Elementary School				
Partial	First Floor Demolition Plan			BM01B

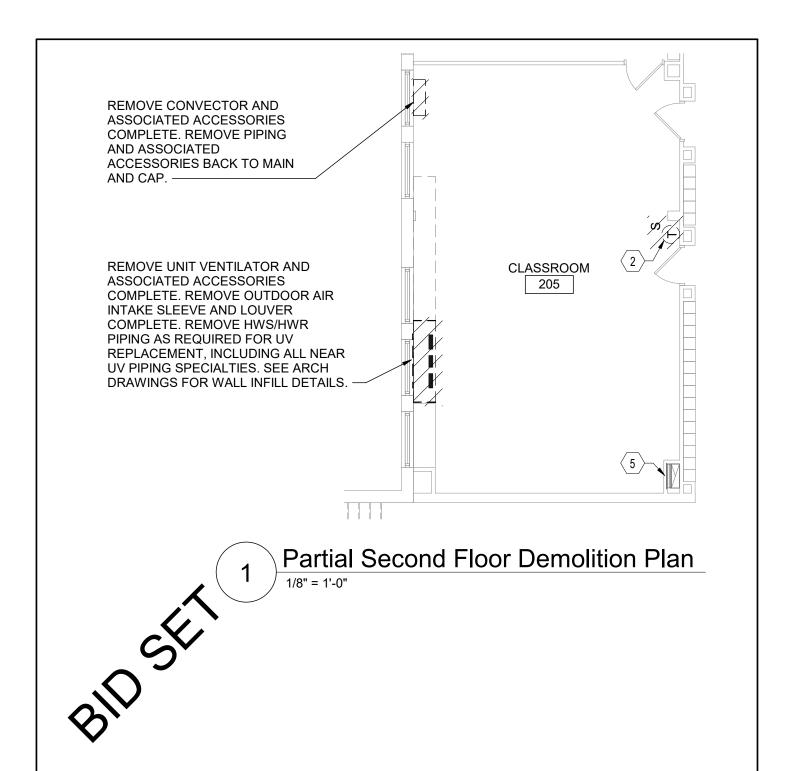


Issued By Bid Addendum #2

			Proj. No.: 339070-24002
TETRATECH ARCHITECTS & ENGINEERS			Date:05/15/25
Tetra Tech Engineers, Architects & Landscape Architects, P.C.	Rev.:	Date:	Drawn By: pgm/DPM
Waverly Central School District			Drawing No.:
Elm Street Elementary School			
Partial Second Floor Demolition Plan			BM02B

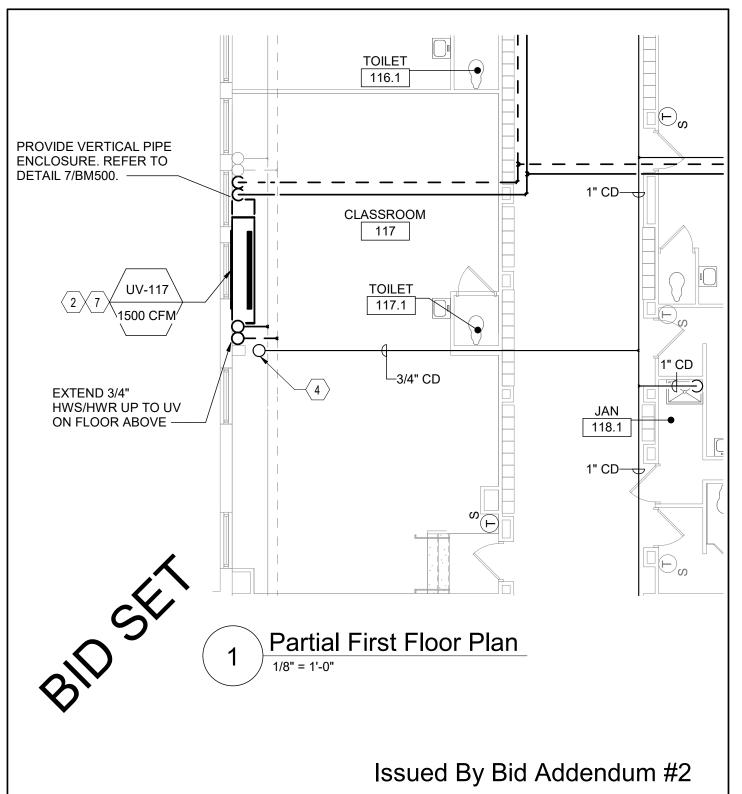


TETRATECH ARCHITECTS & ENGINEERS Tetra Tech Engineers, Architects & Landscape Architects, P.C. Waverly Central School District Elm Street Elementary School Partial First Floor Plan Proj. No.: 339070-24002 Date: 05/15/25 Rev.: Date: Drawn By: pgm/DPM Drawing No.: BM03B

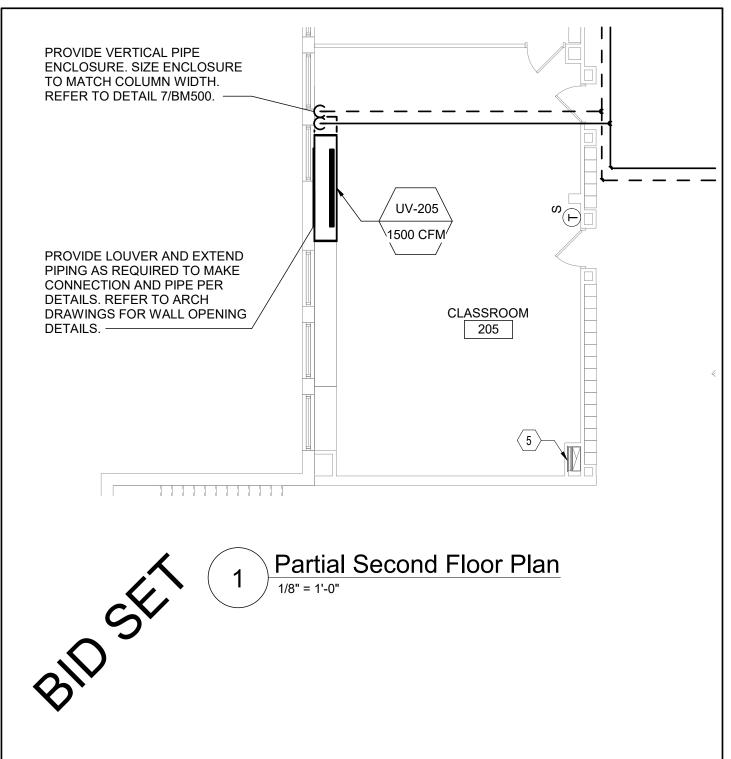


Issued By Bid Addendum #2

			Proj. No.: 339070-24002
TETRATECH ARCHITECTS & ENGINEERS			Date:05/15/25
Tetra Tech Engineers, Architects & Landscape Architects, P.C.	Rev.:	Date:	Drawn By: pgm/DPM
Waverly Central School District			Drawing No.:
Elm Street Elementary School			
Partial Second Floor Plan			BM04B

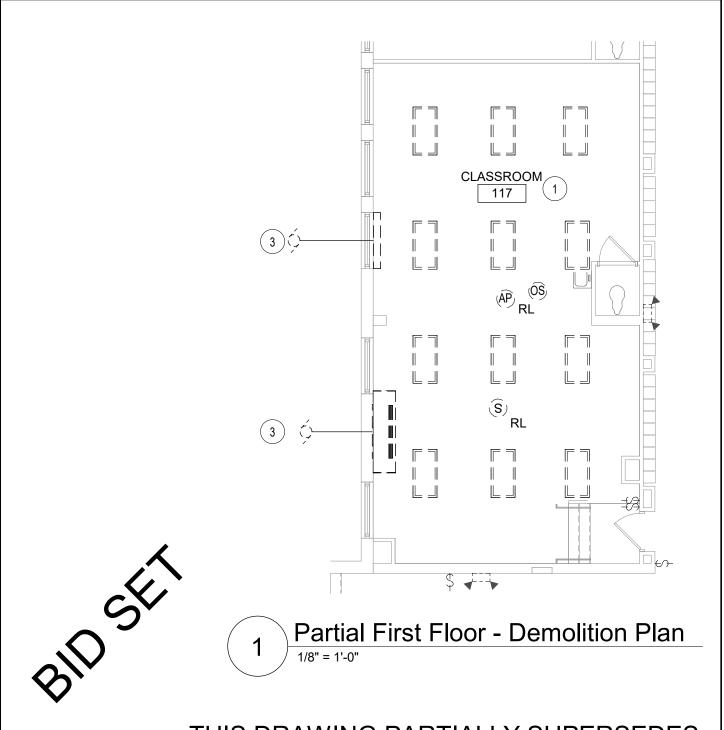

			Proj. No.: 339070-24002
TETRATECH ARCHITECTS & ENGINEERS			Date:05/15/25
Tetra Tech Engineers, Architects & Landscape Architects, P.C.	Rev.:	Date:	Drawn By: SAS
Waverly Central School District	Drawing No.:		
Elm Street Elementary School			
Partial First Floor - Demolition Plan			BE01B

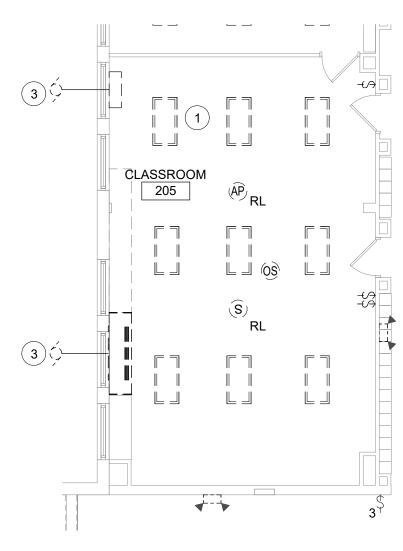


BIDSET


1 Partial Second Floor - Demolition Plan

1/8" = 1'-0"

			Proj. No.: 339070-24002
TETRATECH ARCHITECTS & ENGINEERS			Date:05/15/25
Tetra Tech Engineers, Architects & Landscape Architects, P.C.	Rev.:	Date:	Drawn By: SAS
Waverly Central School District			Drawing No.:
Elm Street Elementary School			
Partial Second Floor - Demolition Plan			BE02B

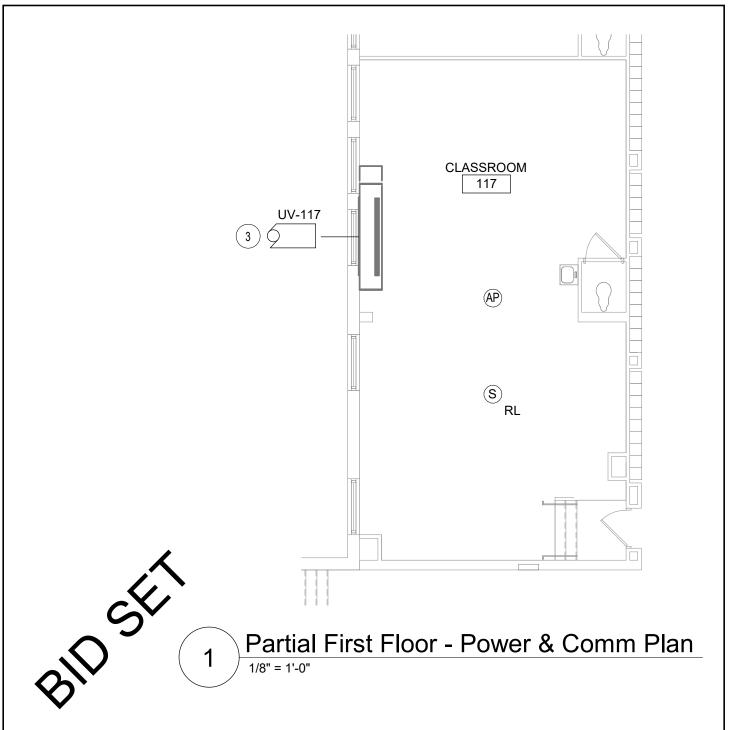

			Proj. No.: 339070-24002
TETRATECH ARCHITECTS & ENGINEERS			Date:05/15/25
Tetra Tech Engineers, Architects & Landscape Architects, P.C.	Rev.:	Date:	Drawn By: SAS
Waverly Central School District			Drawing No.:
Elm Street Elementary School			
Partial First Floor - Power & Comm Plan			BE03B

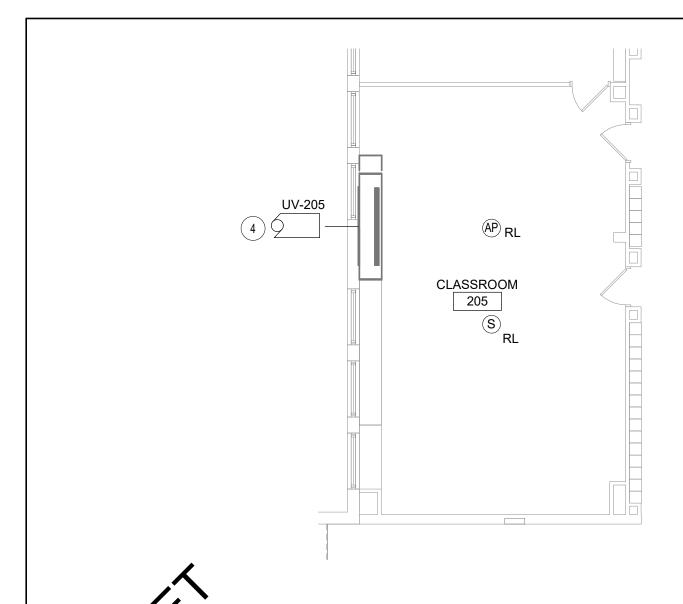

1 Partial Second Floor - Power & Comm Plan

			Proj. No.: 339070-24002
TETRATECH ARCHITECTS & ENGINEERS			Date:05/15/25
Tetra Tech Engineers, Architects & Landscape Architects, P.C.	Rev.:	Date:	Drawn By: SAS
Waverly Central School District			Drawing No.:
Elm Street Elementary School			
Partial Second Floor - Power & Comm Plan			BE04B

